

MODEL: CEDAR MHA03U

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SQUARE FOOTAGE

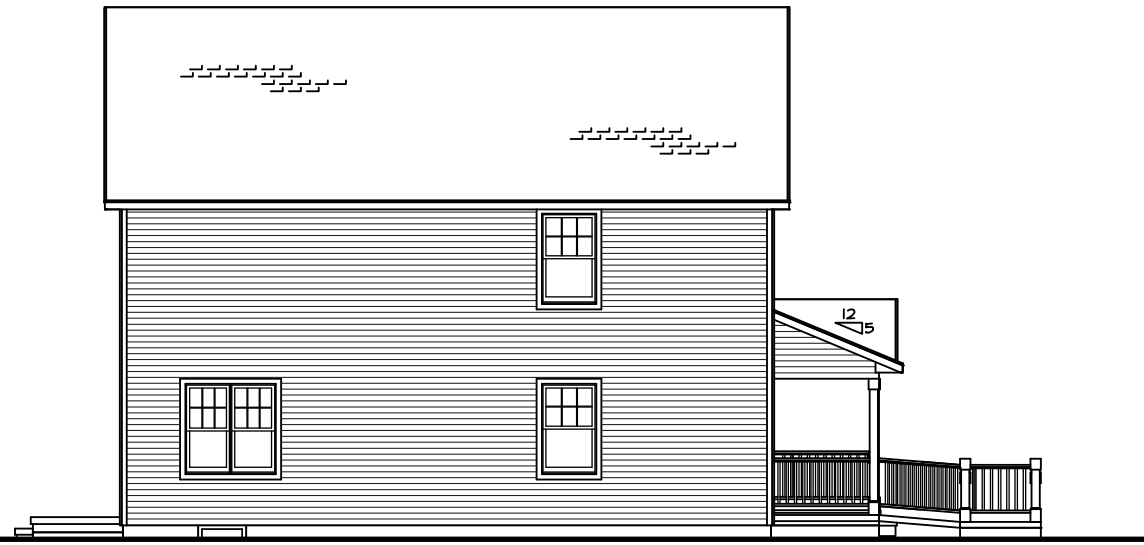
| | | |
|--------------------|-------|--------|
| BASEMENT | 936 | SQ.FT. |
| FIRST FLOOR | 936 | SQ.FT. |
| SECOND FLOOR | 936 | SQ.FT. |
| TOTAL LIVING SPACE | 1,872 | SQ.FT. |



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| MODEL: | CEDAR MHA03U | PRINT DATE: | 05/17/2005 |
| TOWN: | HOUSING AUTHORITY OF MILWAUKEE | ORDER NO.: | MHA03U |
| SHEET NO.: | CS | | |

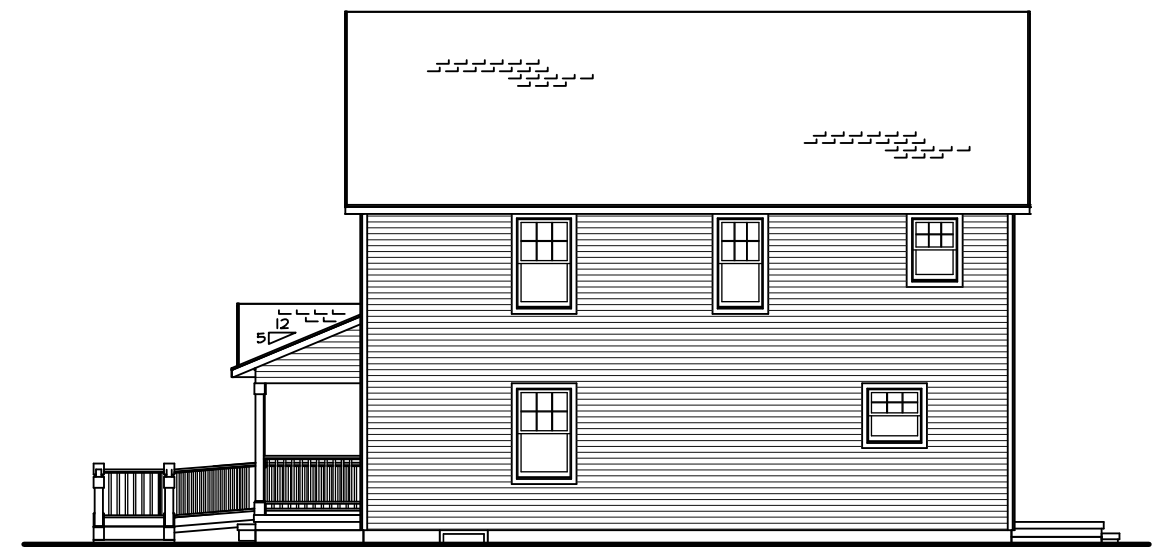
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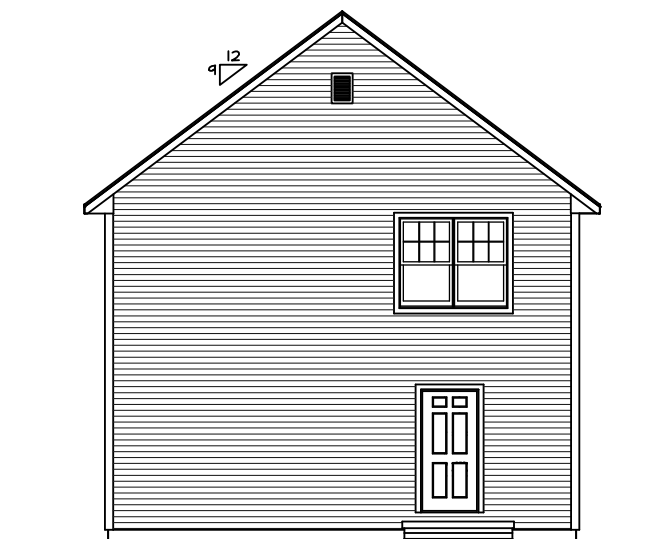
LEFT ELEVATION

SCALE: 3/32" = 1'-0"



RIGHT ELEVATION

SCALE: 3/32" = 1'-0"



REAR ELEVATION

SCALE: 3/32" = 1'-0"



FRONT ELEVATION

SCALE: 3/16" = 1'-0"

RAMP TO BE DESIGNED LOT SPECIFIC.
FINAL DESIGN & SPECS BY MHA.

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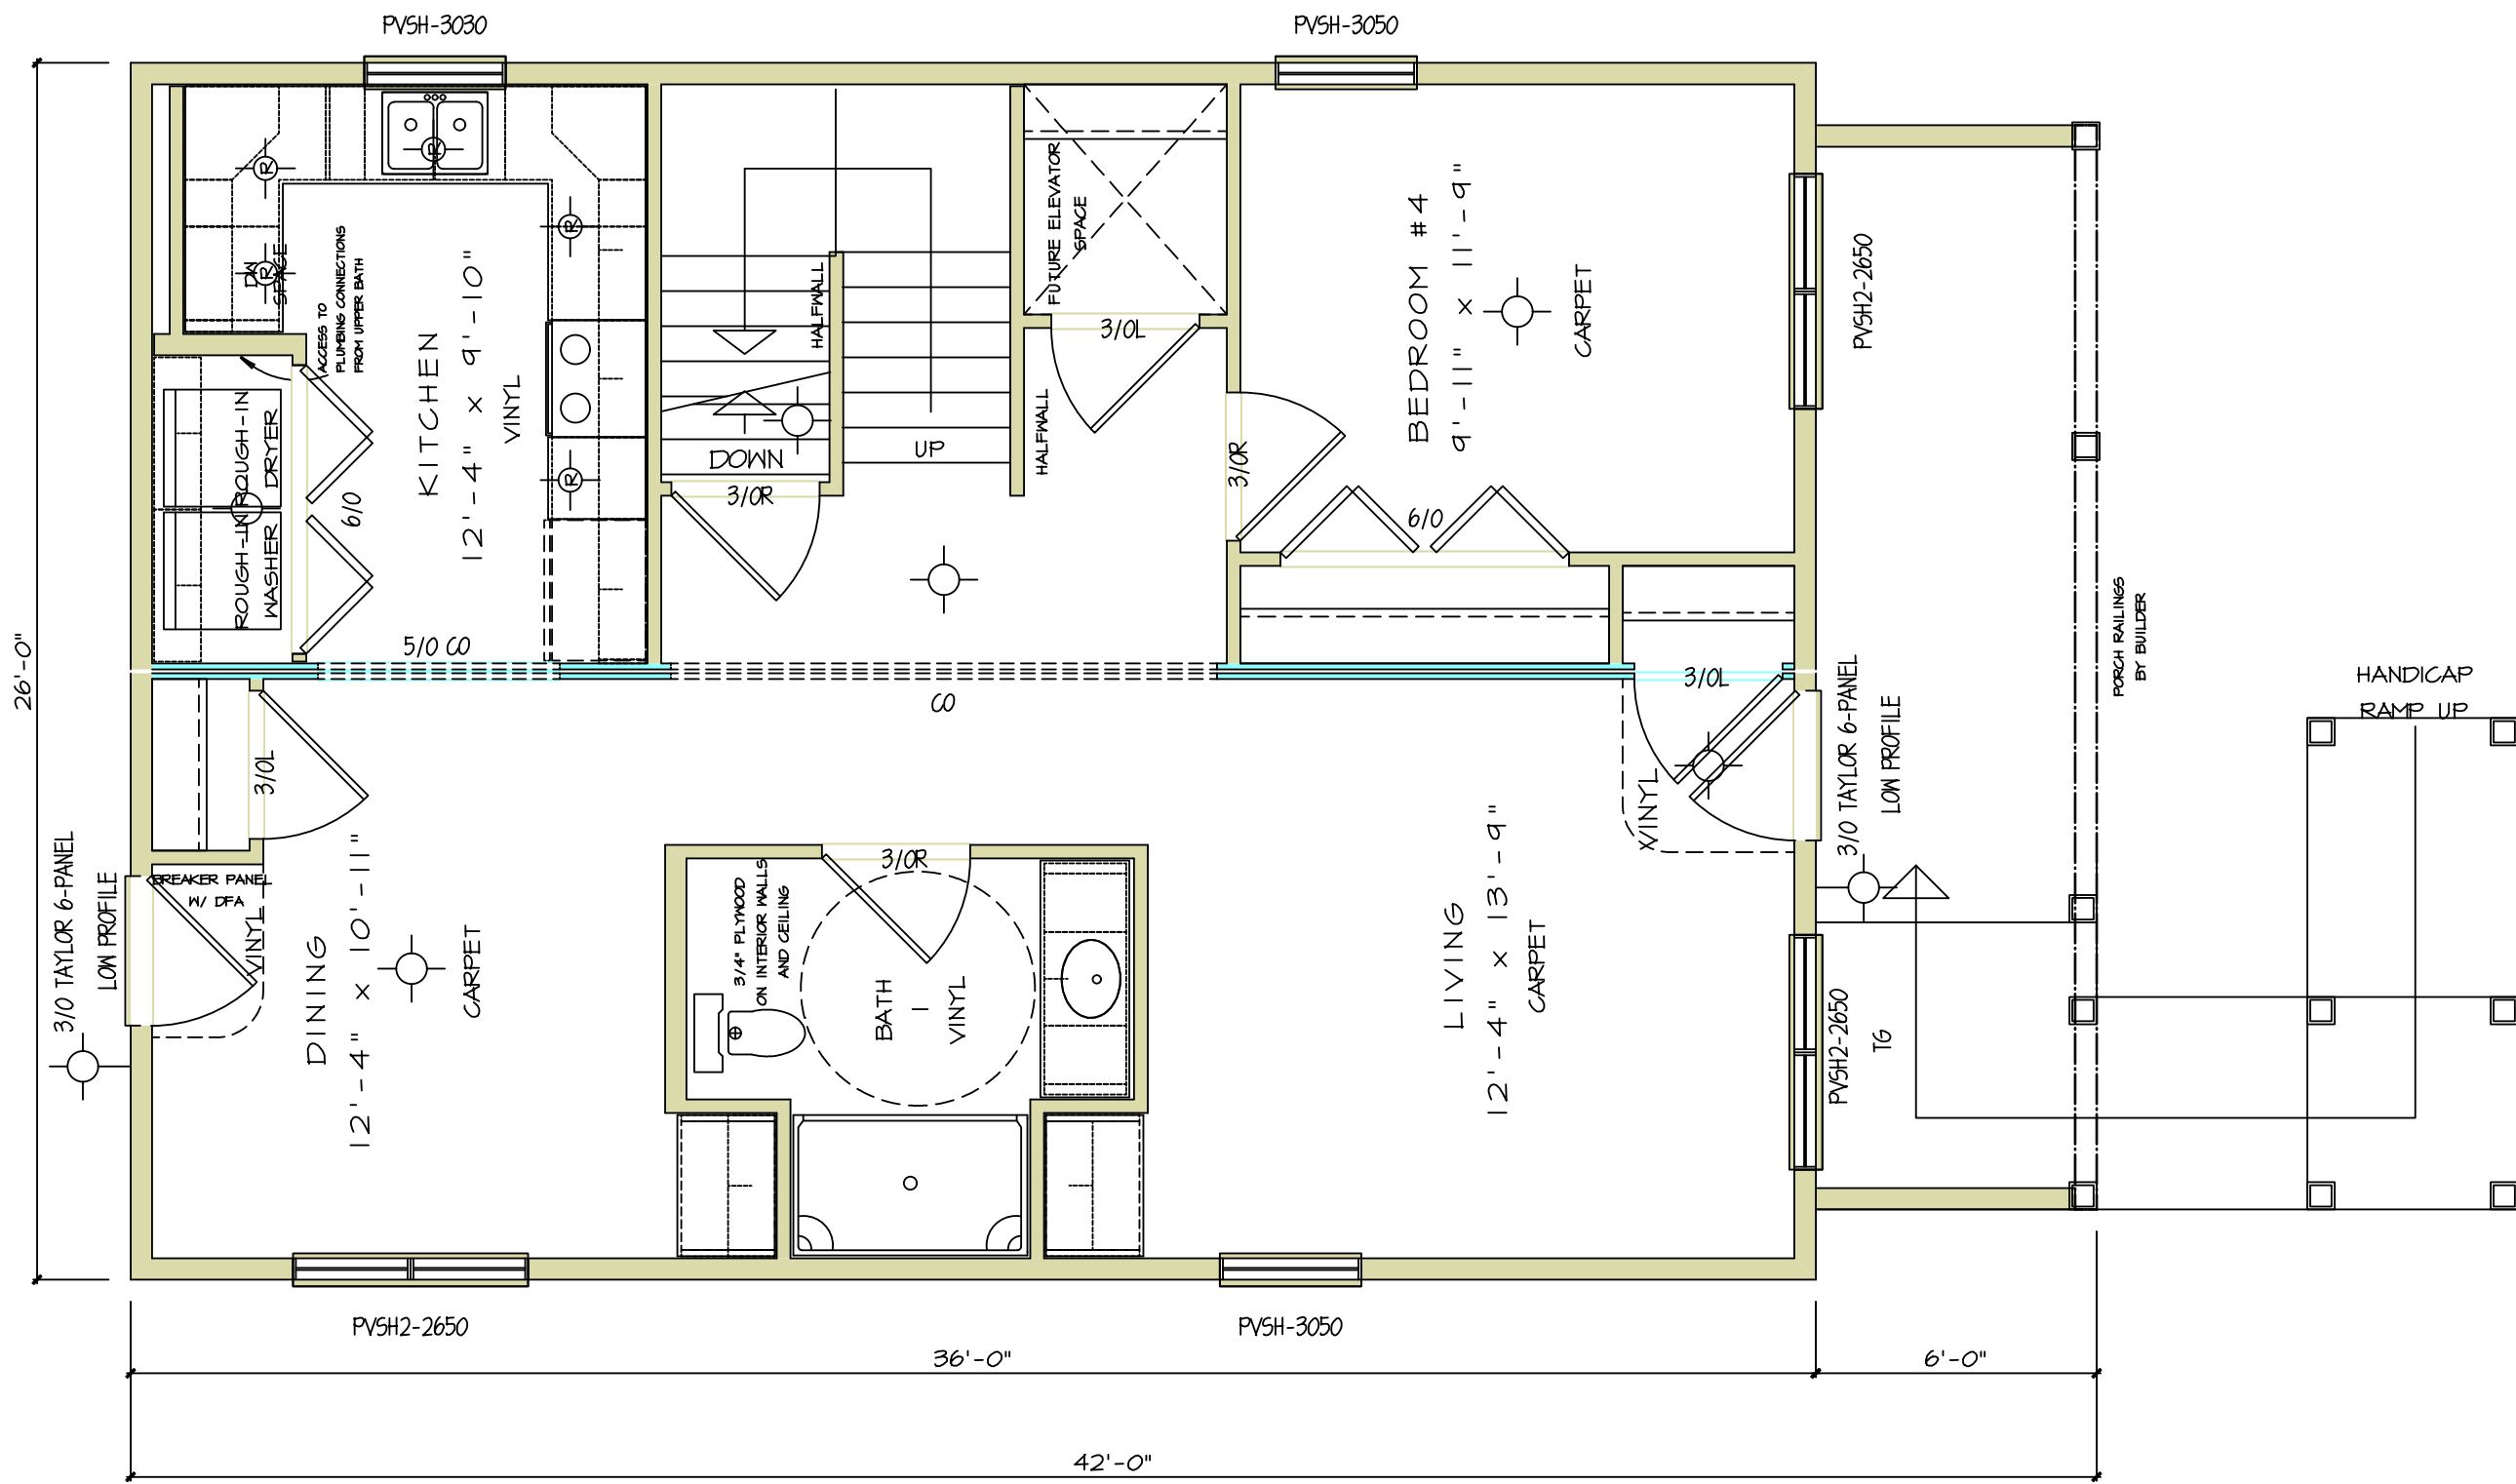
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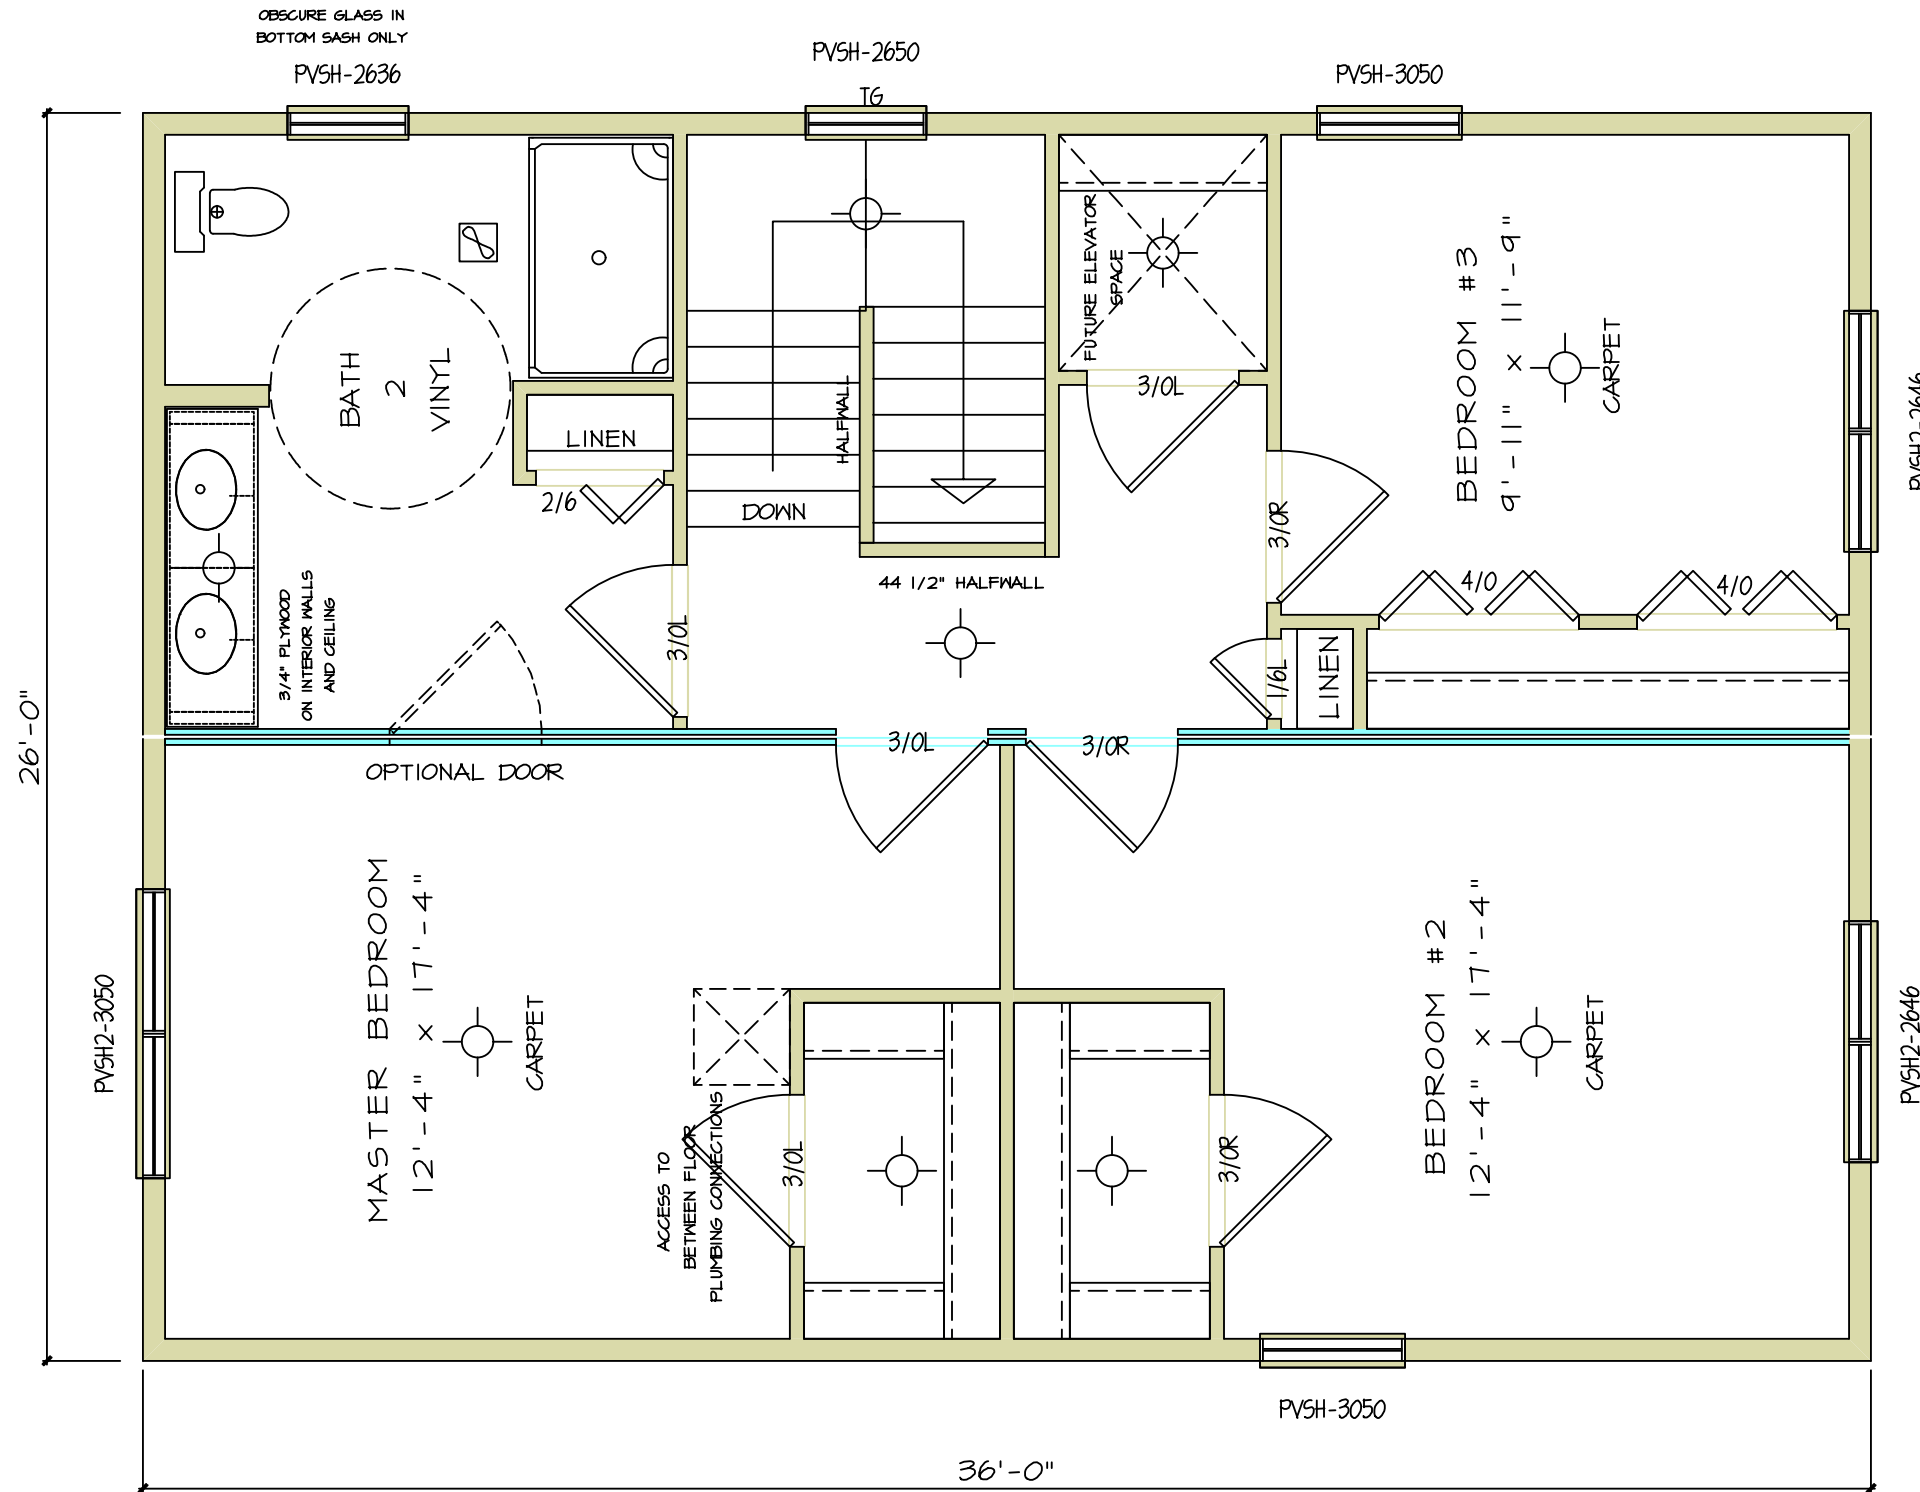
SHEET NO. A1



FIRST FLOOR

SCALE: 1/4" = 1'-0"

| | | | |
|------------------------|---|---------------------------|--|
| SHEET NO. A3 | MODEL: CEDAR MHA03U | PRINT DATE: 05/17/2005 | REVISIONS |
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SECOND FLOOR

SCALE: 1/4" = 1'-0"

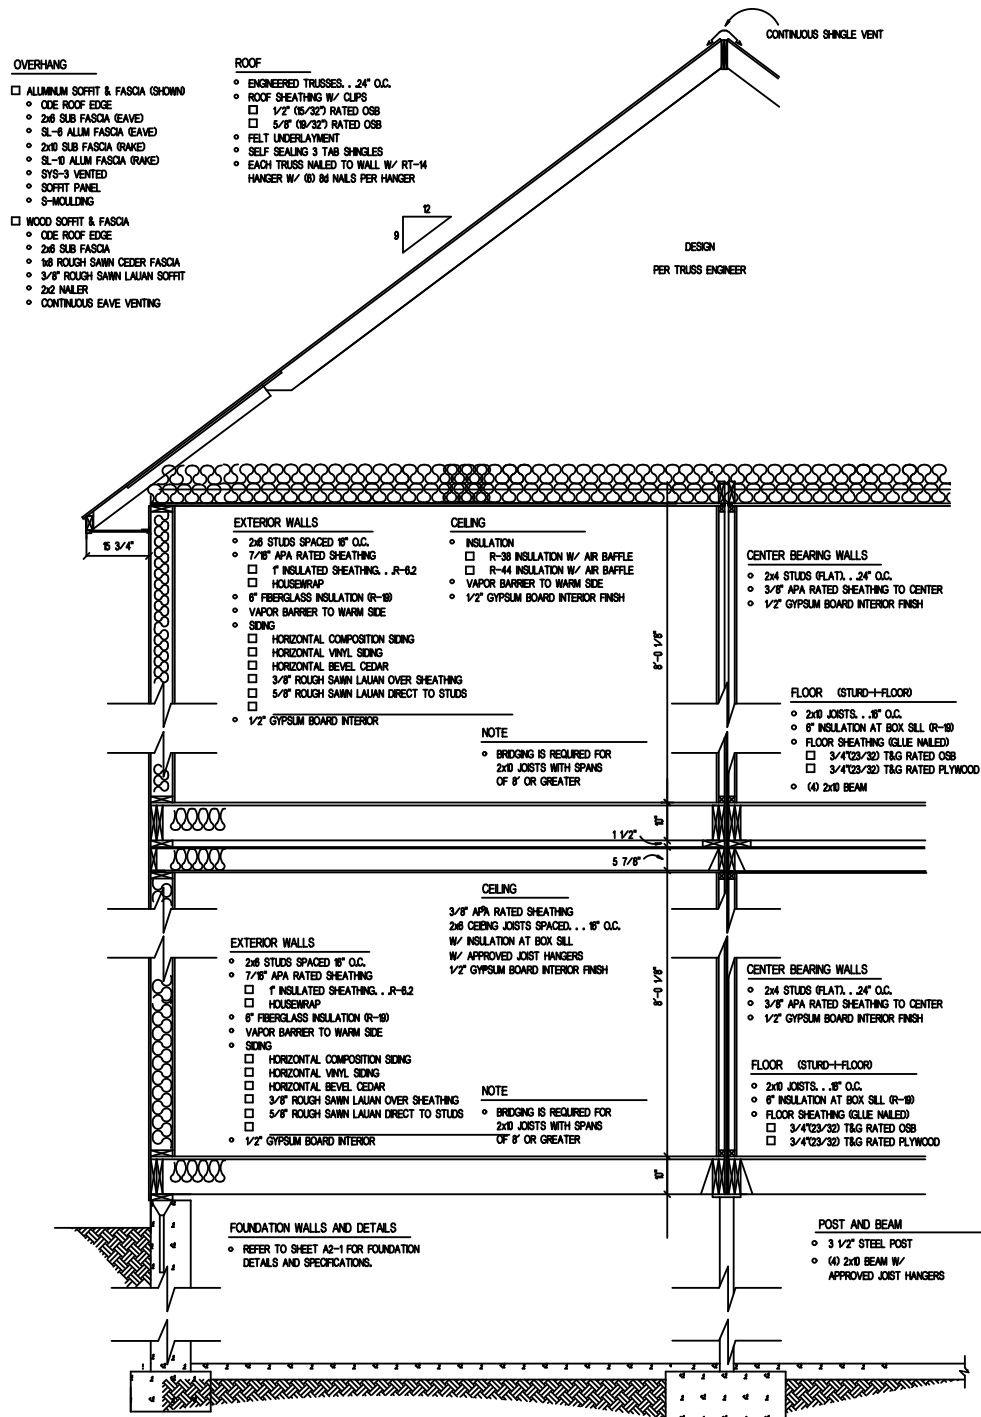
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SHEET NO. A31



- OVERHANG**
- ALUMINUM SOFFIT & FASCIA (SHOWING)
 - ODE ROOF EDGE
 - 2x6 SUB FASCIA (EAVED)
 - SL-6 ALUM FASCIA (EAVED)
 - 2x10 SUB FASCIA (RAKED)
 - SL-10 ALUM FASCIA (RAKED)
 - SYG-3 VENTED SOFFIT PANEL
 - S-MOULDING
- WOOD SOFFIT & FASCIA**
- ODE ROOF EDGE
 - 2x6 SUB FASCIA
 - #6 ROUGH SAWN CEDAR FASCIA
 - 3/4" ROUGH SAWN LAUAN SOFFIT
 - 2x2 HAULER
 - CONTINUOUS EAVE VENTING

- ROOF**
- ENGINEERED TRUSSES, .24" O.C.
 - ROOF SHEATHING W/ CLIPS
 - 1/2" (5/32") RATED OSB
 - 5/8" (19/32") RATED OSB
 - FELT UNDERLAYMENT
 - SELF SEALING 3 TAB SHINGLES
 - EACH TRUSS NAILED TO WALL W/ RT-14 HANGER W/ 60 #6 NAILS PER HANGER

- EXTERIOR WALLS**
- 2x6 STUDS SPACED 16" O.C.
 - 7/8" APA RATED SHEATHING
 - 1" INSULATED SHEATHING, R-6.2
 - HOUSEWRAP
 - 8" FIBERGLASS INSULATION (R-19)
 - VAPOR BARRIER TO WARM SIDE
 - SIDING
 - HORIZONTAL COMPOSITION SIDING
 - HORIZONTAL VINYL SIDING
 - HORIZONTAL BEVEL CEDAR
 - 3/8" ROUGH SAWN LAUAN OVER SHEATHING
 - 5/8" ROUGH SAWN LAUAN DIRECT TO STUDS
 - 1/2" GYPSUM BOARD INTERIOR

- CEILING**
- INSULATION
 - R-38 INSULATION W/ AIR BAFFLE
 - R-44 INSULATION W/ AIR BAFFLE
 - VAPOR BARRIER TO WARM SIDE
 - 1/2" GYPSUM BOARD INTERIOR FINISH

- CENTER BEARING WALLS**
- 2x4 STUDS (PLAT.), .24" O.C.
 - 3/8" APA RATED SHEATHING TO CENTER
 - 1/2" GYPSUM BOARD INTERIOR FINISH

- FLOOR (STURD-FLOOR)**
- 2x10 JOISTS, .18" O.C.
 - 8" INSULATION AT BOX SILL (R-19)
 - FLOOR SHEATHING (GLUE NAILED)
 - 3/4" (23/32) T&G RATED OSB
 - 3/4" (23/32) T&G RATED PLYWOOD
 - (4) 2x10 BEAM

- EXTERIOR WALLS**
- 2x6 STUDS SPACED 16" O.C.
 - 7/8" APA RATED SHEATHING
 - 1" INSULATED SHEATHING, R-6.2
 - HOUSEWRAP
 - 8" FIBERGLASS INSULATION (R-19)
 - VAPOR BARRIER TO WARM SIDE
 - SIDING
 - HORIZONTAL COMPOSITION SIDING
 - HORIZONTAL VINYL SIDING
 - HORIZONTAL BEVEL CEDAR
 - 3/8" ROUGH SAWN LAUAN OVER SHEATHING
 - 5/8" ROUGH SAWN LAUAN DIRECT TO STUDS
 - 1/2" GYPSUM BOARD INTERIOR

- CEILING**
- 3/8" APA RATED SHEATHING
 - 2x6 CEILING JOISTS SPACED, .18" O.C.
 - W/ INSULATION AT BOX SILL
 - W/ APPROVED JOIST HANGERS
 - 1/2" GYPSUM BOARD INTERIOR FINISH

- CENTER BEARING WALLS**
- 2x4 STUDS (PLAT.), .24" O.C.
 - 3/8" APA RATED SHEATHING TO CENTER
 - 1/2" GYPSUM BOARD INTERIOR FINISH

- FLOOR (STURD-FLOOR)**
- 2x10 JOISTS, .18" O.C.
 - 8" INSULATION AT BOX SILL (R-19)
 - FLOOR SHEATHING (GLUE NAILED)
 - 3/4" (23/32) T&G RATED OSB
 - 3/4" (23/32) T&G RATED PLYWOOD

- FOUNDATION WALLS AND DETAILS**
- REFER TO SHEET A2-1 FOR FOUNDATION DETAILS AND SPECIFICATIONS.

- POST AND BEAM**
- 3 1/2" STEEL POST
 - (4) 2x10 BEAM W/ APPROVED JOIST HANGERS

CROSS SECTION
SCALE: 1/4" = 1'-0"

ROOF TRUSS LOADING SUMMARY

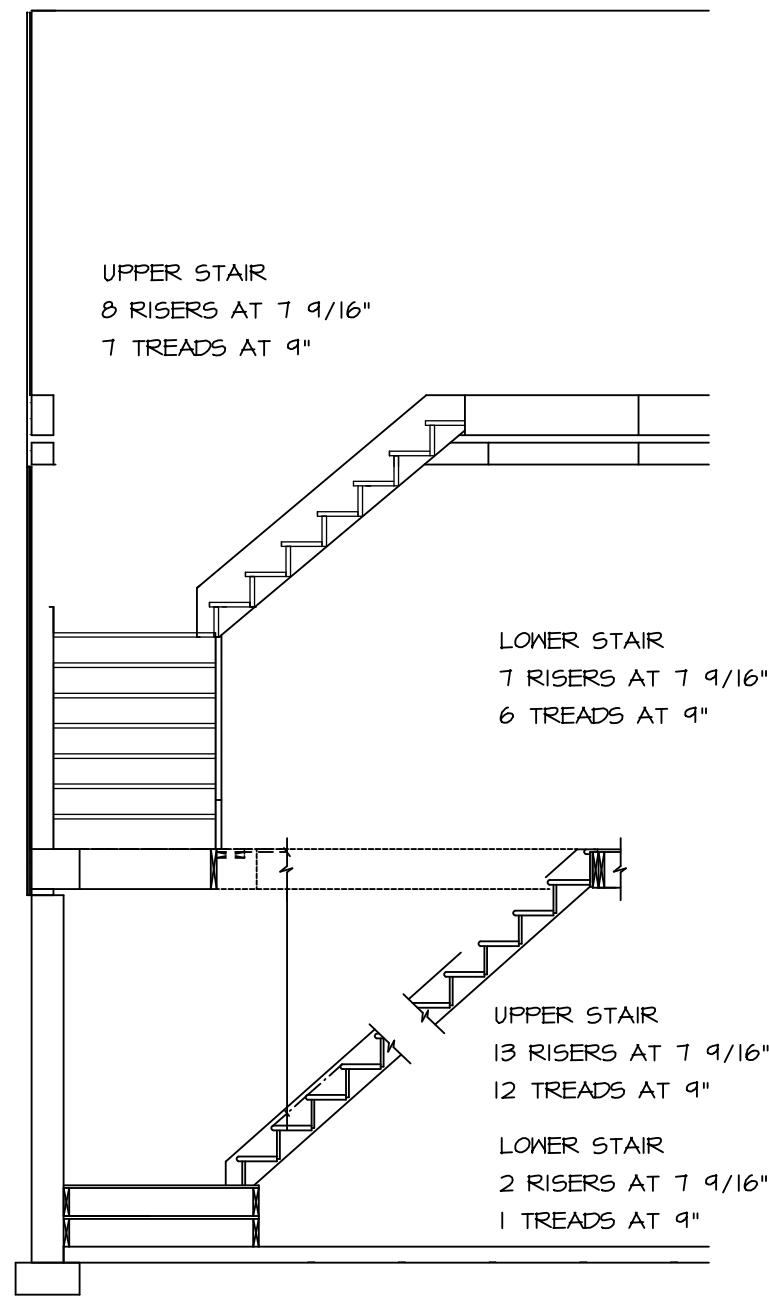
| LOADING | LIVE | DEAD |
|---------|---------|----------|
| TOP CHD | XX PSF | 7.0 PSF |
| BTM CHD | 0.0 PSF | 10.0 PSF |
| TOTAL | XX PSF | 17.0 PSF |

FLOOR LOADING SUMMARY

| | |
|-----------|----------|
| LIVE LOAD | 40.0 PSF |
| DEAD LOAD | 10.0 PSF |

GENERAL NOTES

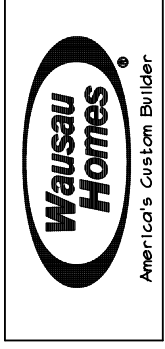
- SOFFIT VENTS AND RIDGE VENTS TO PROVIDE A MINIMUM VENTILATION OF 1/300TH OF THE HORIZONTAL PROJECTION OF THE ROOF AREA.
- ATTIC ACCESS PROVIDED BY 22" x 30" ACCESS OPENING.
- FLOOR TO SILL HEIGHT OF BEDROOM WINDOWS TO BE 44" MAX.
- FOUNDATION INSULATION PER LOCAL CODE REQUIREMENTS.
- BUILDER TO INSTALL STAIR RAILING TO THE BASEMENT STAIRS PER LOCAL CODE REQUIREMENTS.
- A SMOKE DETECTOR SHALL BE PROVIDED ON ALL LEVELS AND WILL BE INTERCONNECTED.



STAIR SECTION
SCALE: 1/4" = 1'-0"

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SHEET NO. A4